SW100

PROPOSED RESIDENTIAL DEVELOPMENT 12-16 FRANCIS STREET, MINTO STORMWATER CONCEPT DESIGN



	DRAWINGS LIST										
REV	TITLE	DW	SHEET No.								
D	COVER SHEET	SV	1								
D	STORMWATER CONCEPT DESIGN - BASEMENT PLAN	SW	2								
D	STORMWATER CONCEPT DESIGN - GROUND FLOOR PLAN	SV	3								
D	STORMWATER CONCEPT DESIGN - ROOF PLAN	SW	4								
D	STORMWATER CONCEPT DESIGN - EMERGENCY OVERLAND FLOW PLAN	SW	5								
D	STORMWATER CONCEPT DESIGN - DETAILS SHEET	SW	6								
D	EROSION AND SEDIMENT CONTROL - PLAN AND DETAILS	SW	7								
D	STORMWATER CONCEPT DESIGN - MUSIC CATCHMENT PLAN	SW	8								

LOCALITY PLAN NOT TO SCALE
COPYRIGHT OF GOOGLE MAP, VERSION 3)



PREPARED BY:

SGC Consulting Engineers Suite 5.03, Level 5 156 Pacific Highway St. Leonards, NSW 2065 T: +61 2 8883 4239 Email: office@sgce.com.au Engineering Value Web: www.sgce.com.au


ARCHITECT:

URBAN LINK PTYLTD P.0.BOX 2223, BURWOOD NORTH p 02-9745 2014 f 02-9745 0984 e info@urbanlink.com.au

CLIENT:

AIMAN YOUSIF AUSTRALIAN **CONSTRUCTION EXPERTS** PTY LTD.



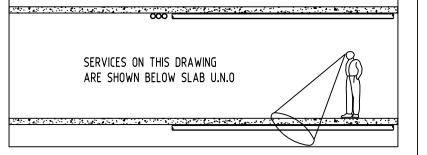



100yr 2hr ARI STORM = 38.6mm/hr $ARI \times 2 = 77.2mm$ AREA OF DRIVEWAY

VOLUME OF RUNOFF $V = A \times d$ = 94.8 x (77.2 / 1000)


 $= 7.32 \text{m}^3$


RAMP UNCOVERED = 94.8m²

WET WELL STORAGE MAXIMUM OF: * VOLUME OF RUNOFF


THEREFORE, A VOLUME OF 7.32m3 SUBSOIL PUMP OUT PIT WILL BE APPLIED AS PER AUSTRALIAN STANDARD (AS3500).

		Out	nut	0	tlet	Rat	ted	Maxi	mum	Weigh		Dimension	
	Type	Out	put	Ou	tiet	Head C	apacity	Head	Capacity	weign		Dimension	1
		HP	kW	mm	Inch	M	LPM	M	LPM	Kg	L(mm)	W(mm)	H(mm)
	KS-03	1/3	0.25	40	1 1/2"	3	130	8	180	9	188	141	305
	KS-04	1/2	0.4	50	2"	5	150	8	220	11	208	140	359
	KS-05	1/2	0.4	50	2"	5	160	10	260	14	230	156	375
	KS-08	1	0.75	50	2"	6	240	13	380	21	290	180	425
	KS-20	2	1.5	80	3"	10	300	16	600	31	278	182	475
	KS-30	3	2.2	80	3"	10	500	18	800	42	390	250	450
MMENDED	KS-50	5	3.7	100	4"	10	800	21	1100	48	450	240	530
OMMENDED P	KS-75	7 1/2	5.6	100	4"	15	800	23	1300	60	550	310	590
'	KS-100	10	7.5	150	6"	18	900	25	1600	70	550	310	610

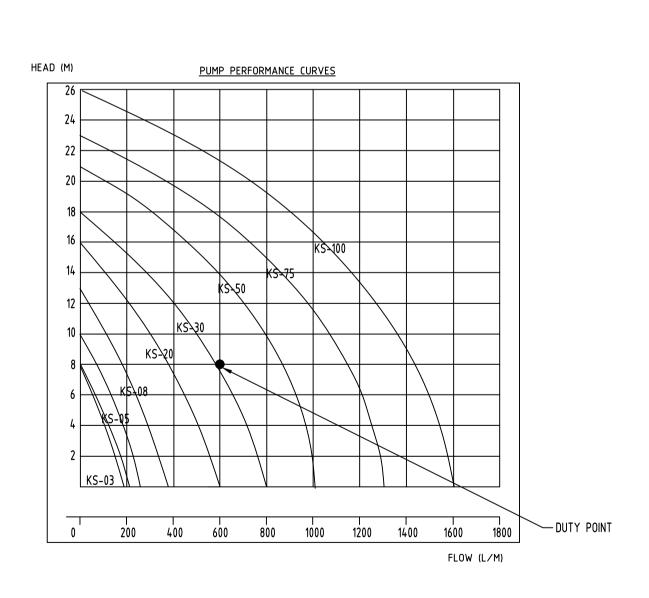

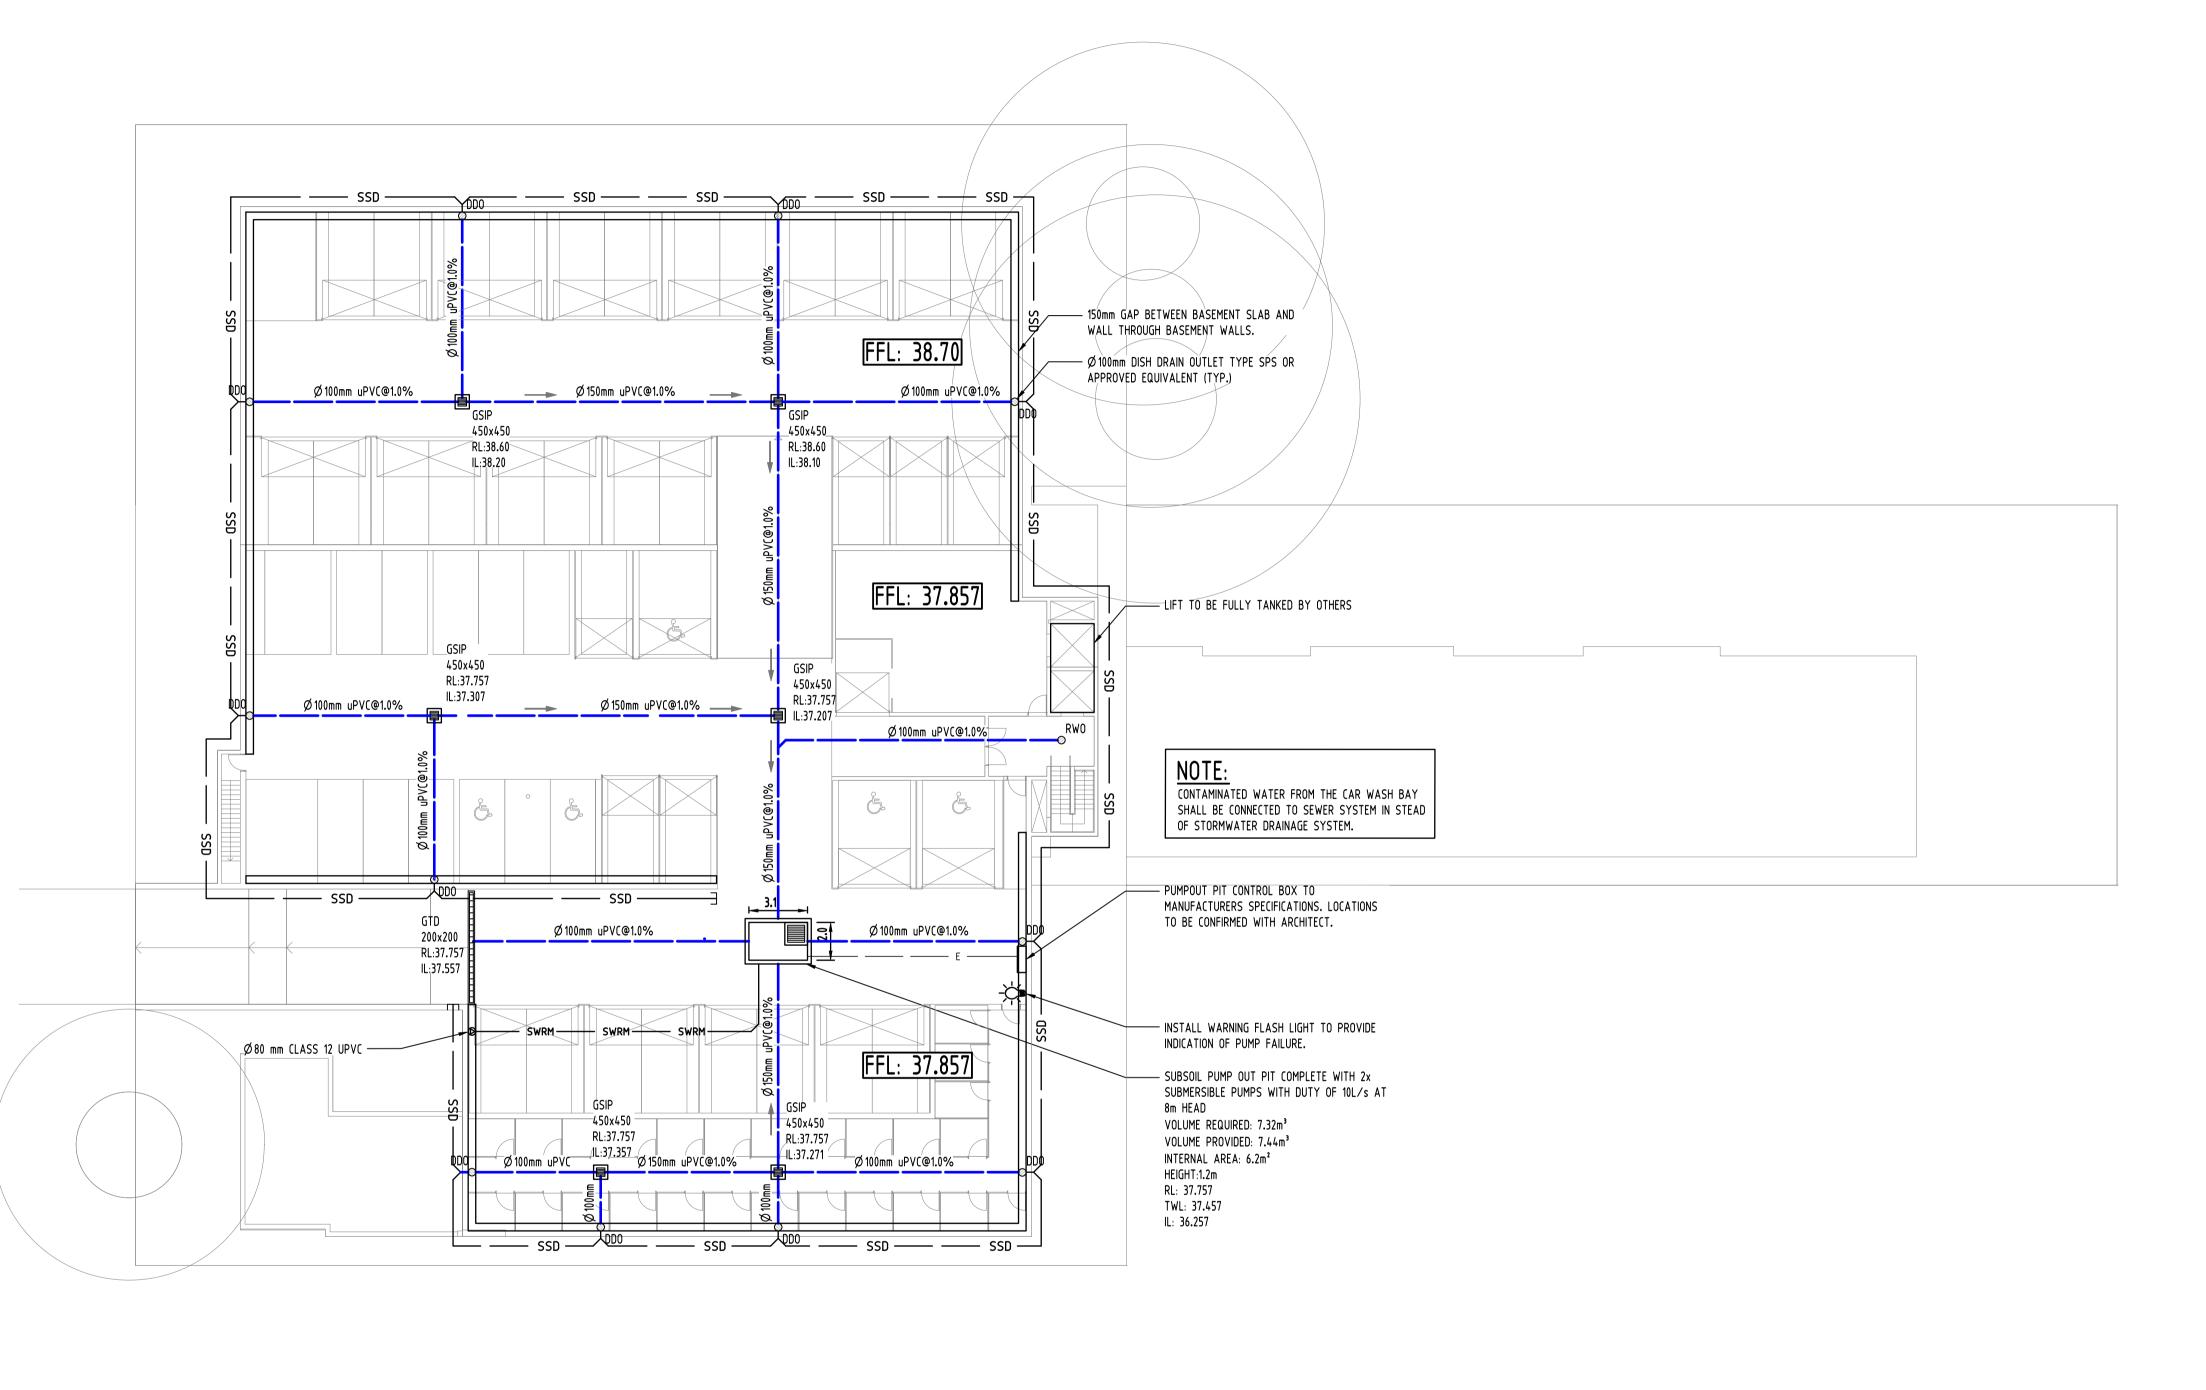

					Reference	Coordination Drawing			ENGINEERS		QUALITY	CONTROL		W/ Th
D	AMENDED AS PER COUNCIL'S COMMENTS	JD	27.07.2020	2	Discipline	Drawing Title and Number	Date	Rev.	AUSTRALIA Chartered Professional Engineer					PF NO
[AMENDED AS PER COUNCIL'S COMMENTS	JD	09.07.2020	2	ARCH	<u> </u>			MEMBER	DRAWN	FZ	DATE	26.03.19	W
В	AMENDED AS PER COUNCIL'S COMMENTS	FZ	15.10.19	2	ARCH			1						w
A	FOR APPROVAL	FZ	26.03.19	2	STRUCT	+	+		DIMENSIONS NOT SHOWN TO BE CHECKED ON	CHECKED	SH	DATE	26.03.19	
P3	PRELIMINARY	FZ	22.03.19	1	MECH				SITE. DO NOT SCALE OF THIS DRAWING.	1				
P2	PRELIMINARY	FZ	21.03.19	1			+		POSITIONS OF AUTHORITIES MAINS AND/OR EXISTING SERVICES ARE TO BE CHECKED	DESIGNED	FZ	DATE	26.03.19	1
P1	PRELIMINARY	FZ	20.03.19	1	ELEC				PRIOR TO COMMENCEMENT OF WORK, REPORT			57112	200030.7	
ssue	Last revision title	by		Status	HYD FIRE				ANY DISCREPANCIES TO THE CONSULTING ENGINEER FOR DECISION/CLARIFICATION	VERIFIED	SH	DATE	26.03.19	1
	Issuer internal sequence and revision his	storv	/		LANDS				BEFORE PROCEEDING WITH THE WORK, THIS					
1-	•	•	, tion certifico	ate	CIVIL				DRAWING IS TO BE READ IN CONJUNCTION WITH THE SPECIFICATIONS AND OTHER	APPROVED	SH	DATE	26.03.19	
4.	-tender 5-construction 6-oth	ner			CHDVEY		1		CONSULTANTS' DRAWINGS.	1				

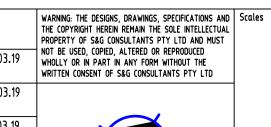

CLIENT AIMAN YOUSIF AUSTRALIAN 0m 2 4 6 8 10 SCALE 1:200 ON ORIGINAL SIZE CONSTRUCTION EXPERTS PTY LTD.

ARCHITECT URBAN LINK PTYLTD LEVEL 10, 11-15 DEANE ST, BURWOOD NSW 2134 P.0.BOX 2223, BURWOOD NORTH NSW 2134 p 02-9745 2014 f 02-9745 0984 e info@urbanlink.com.au



Suite 5.03, Level 5, 156 PACIFIC HIGHWAY ST. LEONARDS, NSW 2065 DEVELOPMENT T: +61 2 8883 4239 Email: office@sgce.com.au 12-16 FRANCIS STREET, Web: www.sgce.com.au

A.B.N. 21 118 222 530

PROJECT PROPOSED RESIDENTIAL

Scale (at original size)

1:200 @ A1

Datum


A.H.D.


2 OF 7

Drawing Status								
-			1 01	' A	PPR0	VAL		
NOT	T0	BE	USED	FOR	CONST	RUCTION	PUR	POSES
Drawing Title								
				_				

STORMWATER CONCEPT DESIGN BASEMENT PLAN

Project No	Drawing No	Revision No
20180132	SW200	D

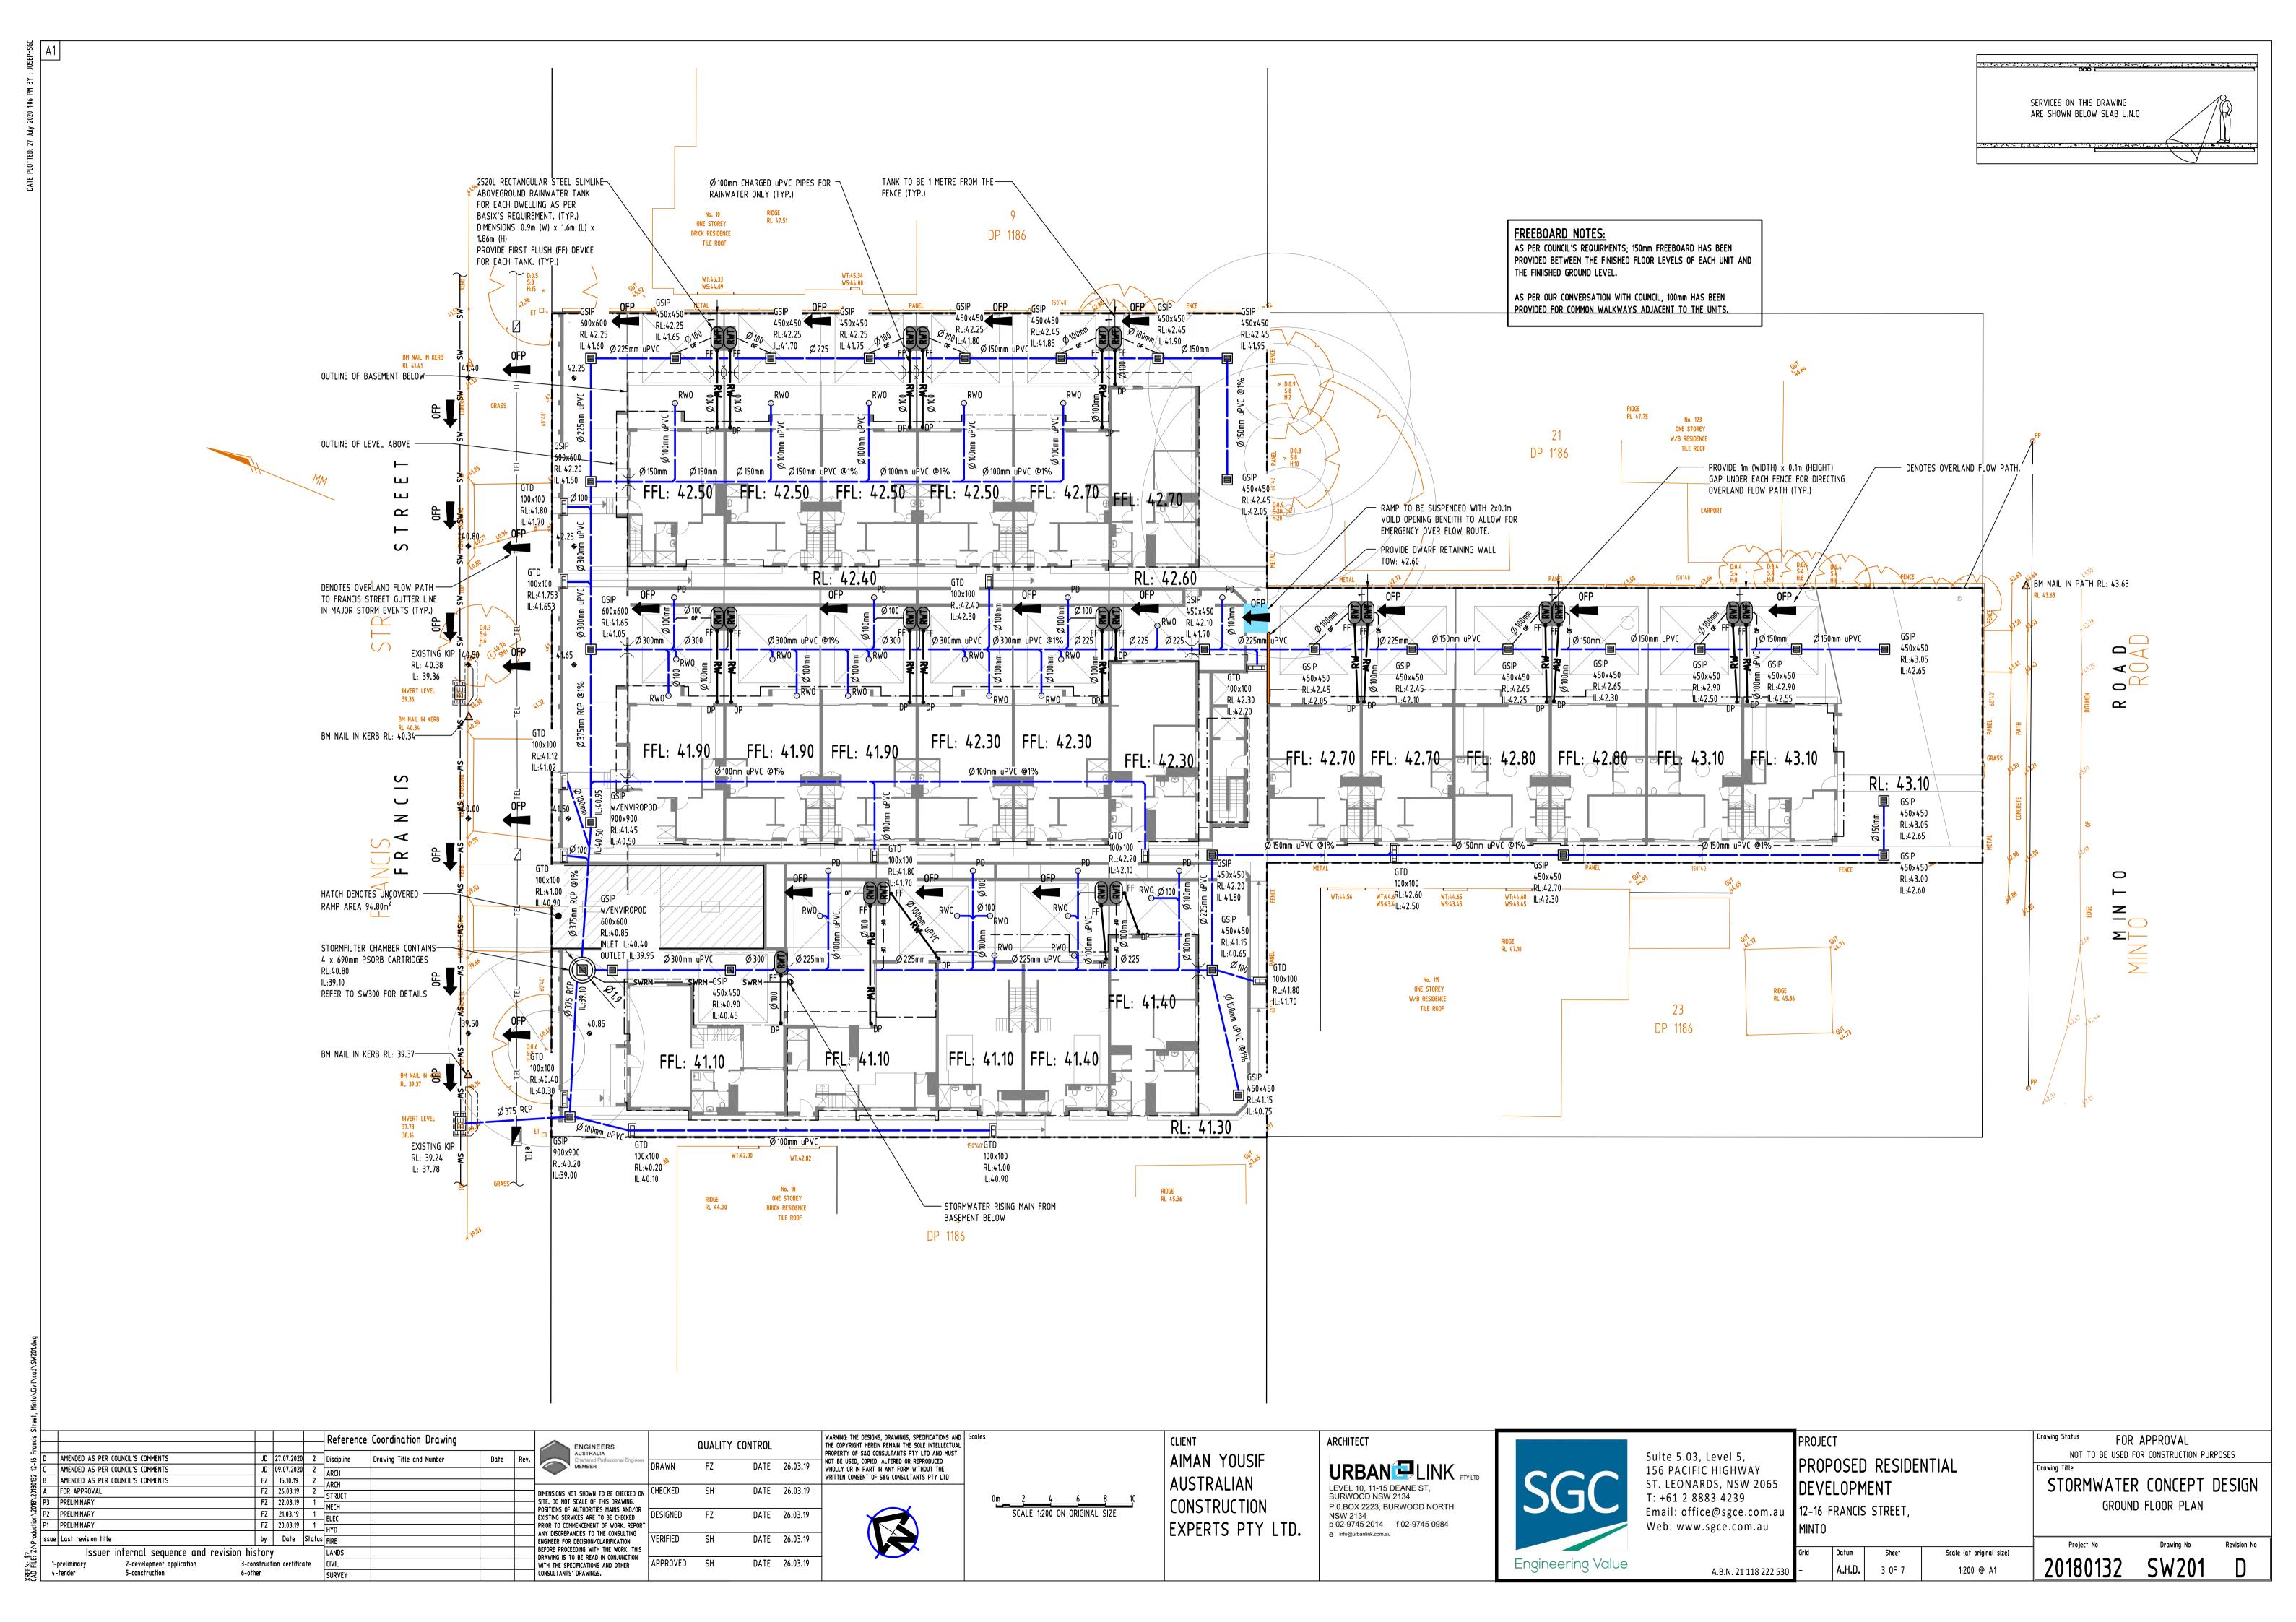

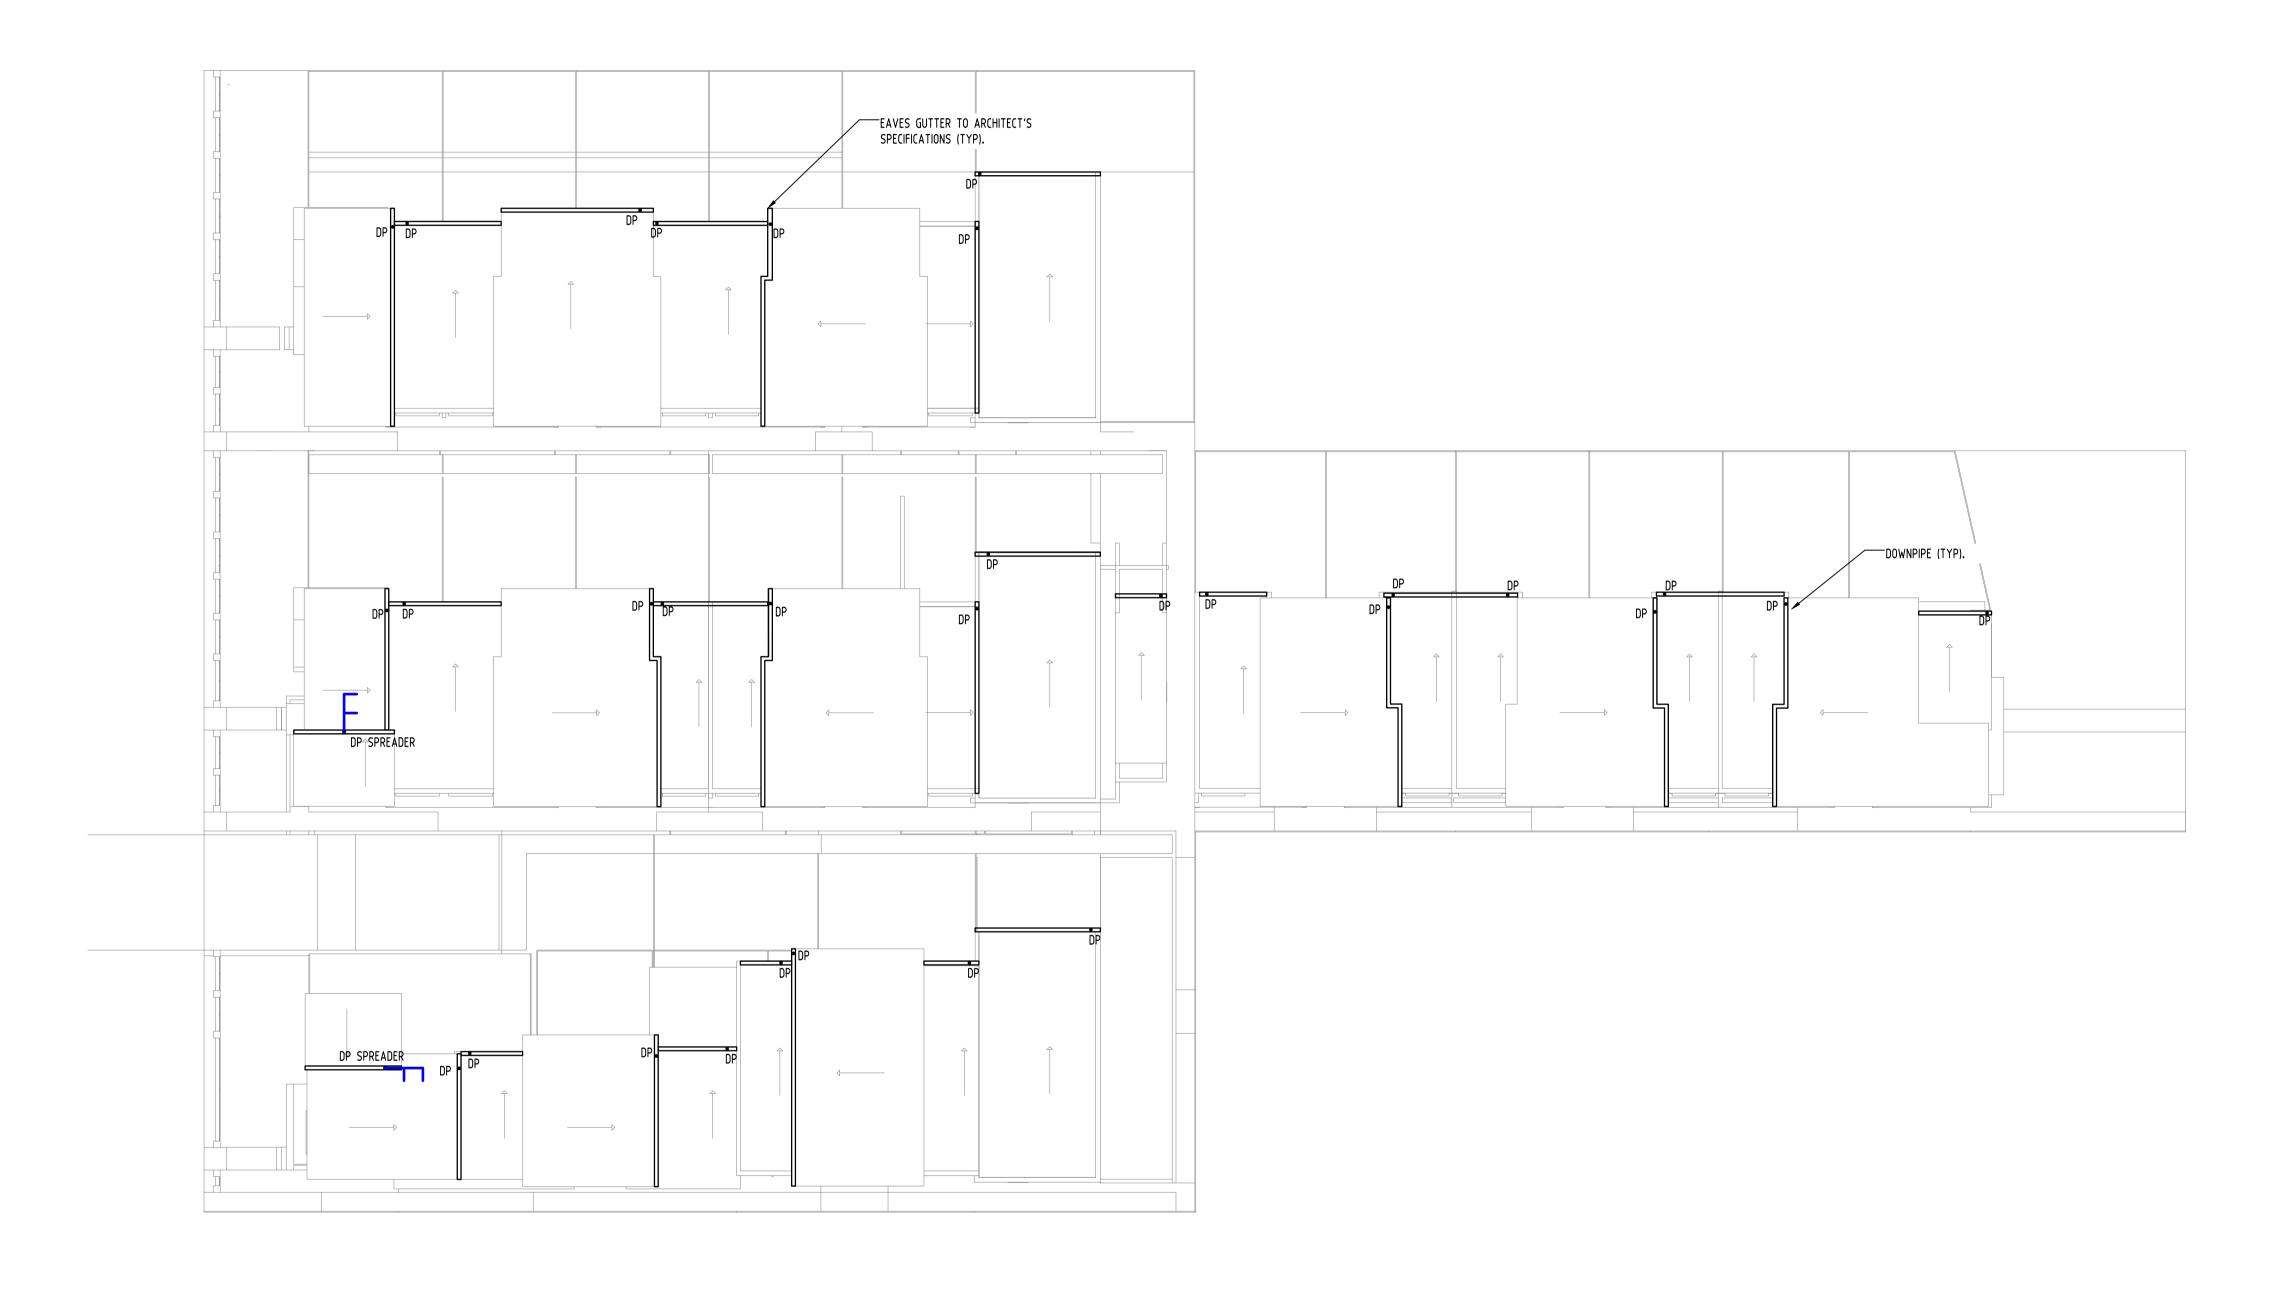

Street															
rancis						Reference	Coordination Drawing			ENGINEERS		QUALITY	CONTROL		WARNI THE C
16 F		AMENDED AS PER COUNCIL'S COMMENTS	JD	27.07.2020	2	Discipline	Drawing Title and Number	Date	Rev.	AUSTRALIA Chartered Professional Engineer					PROPE NOT B
-1		AMENDED AS PER COUNCIL'S COMMENTS	JD	09.07.2020	2	ARCH			1	MEMBER	DRAWN	FZ	DATE	26.03.19	WHOLL
20180132	В	AMENDED AS PER COUNCIL'S COMMENTS	FZ	15.10.19	2	ARCH									WRITT
2018	Α	FOR APPROVAL	FZ	26.03.19	2	STRUCT				DIMENSIONS NOT SHOWN TO BE CHECKED ON	CHECKED	SH	DATE	26.03.19	
≨		PRELIMINARY	FZ	22.03.19	1	MECH			1	SITE. DO NOT SCALE OF THIS DRAWING.					
ڄ	P2	PRELIMINARY	FZ	21.03.19	1	ELEC				POSITIONS OF AUTHORITIES MAINS AND/OR EXISTING SERVICES ARE TO BE CHECKED	DESIGNED	FZ	DATE	26.03.19	1
Ē	P2 P1	PRELIMINARY	FZ	26.03.19	1	HYD			<u> </u>	PRIOR TO COMMENCEMENT OF WORK. REPORT					
\Produ	Issue	Last revision title	by	Date	Status	FIRE				ANY DISCREPANCIES TO THE CONSULTING ENGINEER FOR DECISION/CLARIFICATION	VERIFIED	SH	DATE	26.03.19	1
ź		Issuer internal sequence and revision his	tory	1		LANDS				BEFORE PROCEEDING WITH THE WORK. THIS DRAWING IS TO BE READ IN CONJUNCTION					
픧	1-			ion certifica	ıte 💮	CIVIL				WITH THE SPECIFICATIONS AND OTHER	APPROVED	SH	DATE	26.03.19	
9	4-	-tender 5-construction 6-oth	er			SUDVEY		1		CONSULTANTS' DRAWINGS.					1

WARNING: THE DESIGNS, DRAWINGS, SPECIFICATIONS AND THE COPYRIGHT HEREIN REMAIN THE SOLE INTELLECTUAL PROPERTY OF S&G CONSULTANTS PTY LTD AND MUST NOT BE USED, COPIED, ALTERED OR REPRODUCED WHOLLY OR IN PART IN ANY FORM WITHOUT THE WRITTEN CONSENT OF S&G CONSULTANTS PTY LTD

0<u>m 2 4 6 8 10</u> SCALE 1:200 ON ORIGINAL SIZE

AIMAN YOUSIF AUSTRALIAN CONSTRUCTION EXPERTS PTY LTD.

ARCHITECT LEVEL 10, 11-15 DEANE ST,
BURWOOD NSW 2134
P.0.BOX 2223, BURWOOD NORTH
NSW 2134
p 02-9745 2014 f 02-9745 0984 e info@urbanlink.com.au

Engineering Value

Suite 5.03, Level 5, 156 PACIFIC HIGHWAY ST. LEONARDS, NSW 2065
T: +61 2 8883 4239
Email: office@sgce.com.au
Web: www.sgce.com.au
MINTO

A.B.N. 21 118 222 530

PROJECT PROPOSED RESIDENTIAL

Scale (at original size)

1:200 @ A1


Datum


A.H.D.

Drawing Status	FOR APPROVAL	
NOT	TO BE USED FOR CONSTRUCTION PU	RP0SE
Drawing Title		
CTOD	MILLATED CONCEDT	DE


STORMWATER CONCEPT DESIGN ROOF PLAN


-	Project No	Drawing No	Revision No
	20180132	SW202	D

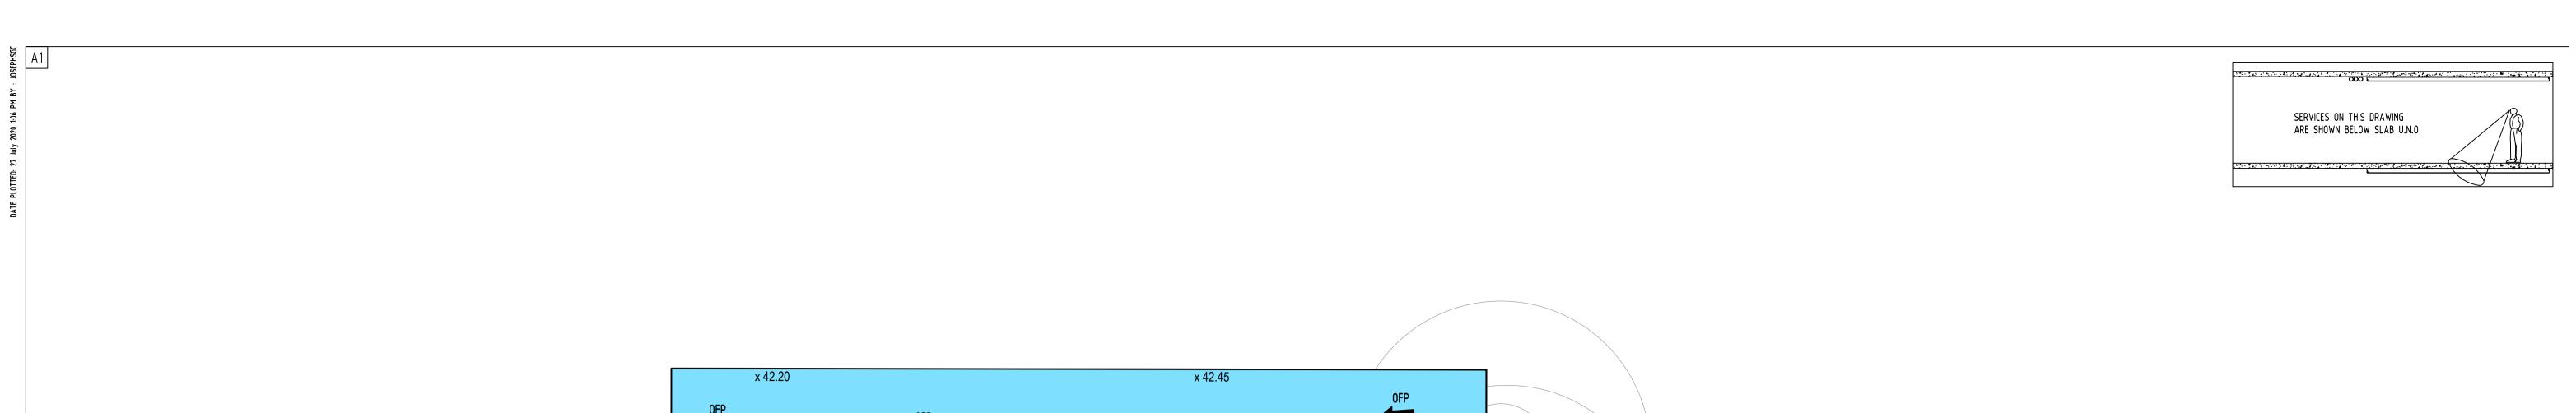


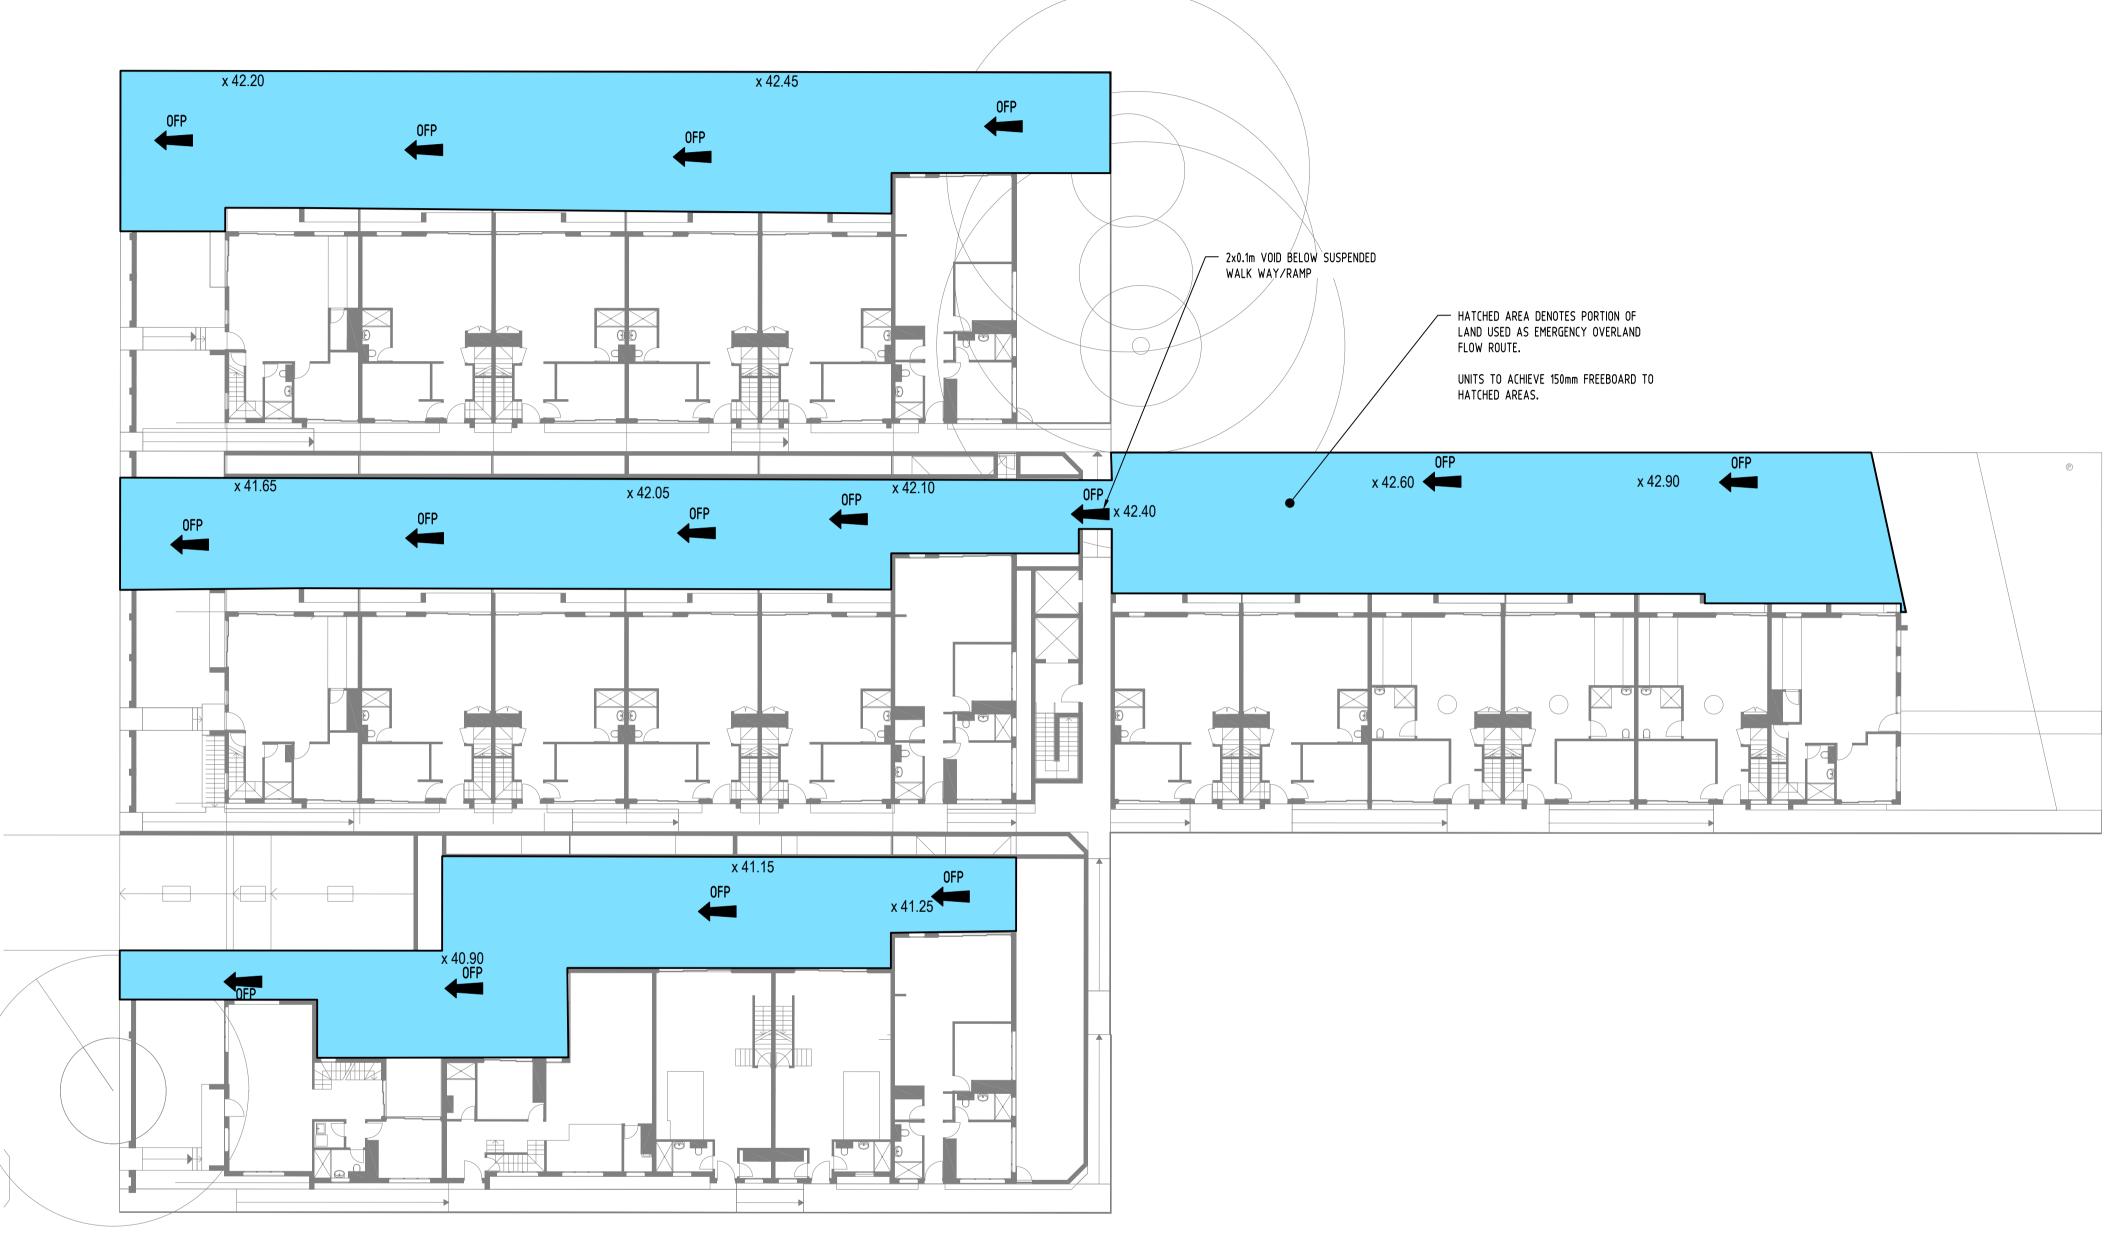

Street,														
12-16 Francis !						Reference	Coordination Drawing			ENGINEERS		QUALITY	CONTROL	
.16 F	D	AMENDED AS PER COUNCIL'S COMMENTS	JD	27.07.2020	2	Discipline	Drawing Title and Number	Date	Rev.	AUSTRALIA Chartered Professional Engineer	55			
		AMENDED AS PER COUNCIL'S COMMENTS	JD	09.07.2020	2	ARCH				MEMBER	DRAWN	FZ	DATE	26.03.19
0132	В	AMENDED AS PER COUNCIL'S COMMENTS	FΖ	15.10.19	2	ARCH								
2018	A	FOR APPROVAL	FΖ	26.03.19	2	STRUCT				DIMENSIONS NOT SHOWN TO BE CHECKED ON	CHECKED	SH	DATE	26.03.19
18	P3	PRELIMINARY	FZ	22.03.19	1	MECH				SITE. DO NOT SCALE OF THIS DRAWING.				
2	P2	PRELIMINARY	FZ	21.03.19	1	ELEC				POSITIONS OF AUTHORITIES MAINS AND/OR EXISTING SERVICES ARE TO BE CHECKED	DESIGNED	FZ	DATE	26.03.19
Ę	P1	PRELIMINARY	FZ	20.03.19	1	HYD				PRIOR TO COMMENCEMENT OF WORK. REPORT				
Z:\Production\2018\20180132	Issue	Last revision title	by		Status	FIRE				ANY DISCREPANCIES TO THE CONSULTING ENGINEER FOR DECISION/CLARIFICATION	VERIFIED	SH	DATE	26.03.19
نکر		Issuer internal sequence and revision hist	ory	1		LANDS				BEFORE PROCEEDING WITH THE WORK. THIS DRAWING IS TO BE READ IN CONJUNCTION				
∏E	1.	-preliminary 2-development application 3-cons	tructi	ion certific	ate	CIVIL				WITH THE SPECIFICATIONS AND OTHER	APPROVED	SH	DATE	26.03.19
XXETS: CAD FILE:	4	-tender 5-construction 6-othe	r			SURVEY				CONSULTANTS' DRAWINGS.				

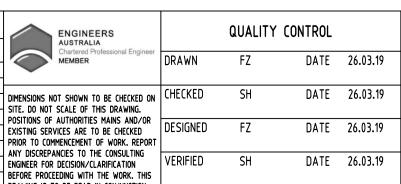

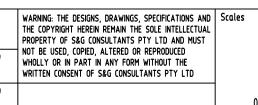

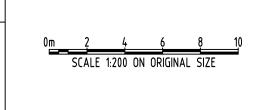

AIMAN YOUSIF AUSTRALIAN CONSTRUCTION EXPERTS PTY LTD.

URBAN LINK PTYLTD LEVEL 10, 11-15 DEANE ST, BURWOOD NSW 2134 P.0.BOX 2223, BURWOOD NORTH NSW 2134 p 02-9745 2014 f 02-9745 0984 e info@urbanlink.com.au



Suite 5.03, Level 5, 156 PACIFIC HIGHWAY ST. LEONARDS, NSW 2065
T: +61 2 8883 4239
Email: office@sgce.com.au
Web: www.sgce.com.au
MINTO

A.B.N. 21 118 222 530

PROJECT PROPOSED RESIDENTIAL

Scale (at original size)

1:200 @ A1

Datum


A.H.D.

3 OF 7

Drawing Status	FOR APPROVAL	
NOT	TO BE USED FOR CONSTRUCTION P	URPOSES
Drawing Title		
STORI	MWATER CONCEPT	DES
	NOT Drawing Title	NOT TO BE USED FOR CONSTRUCTION P

EMERGENCY OVERLAND FLOW PLAN



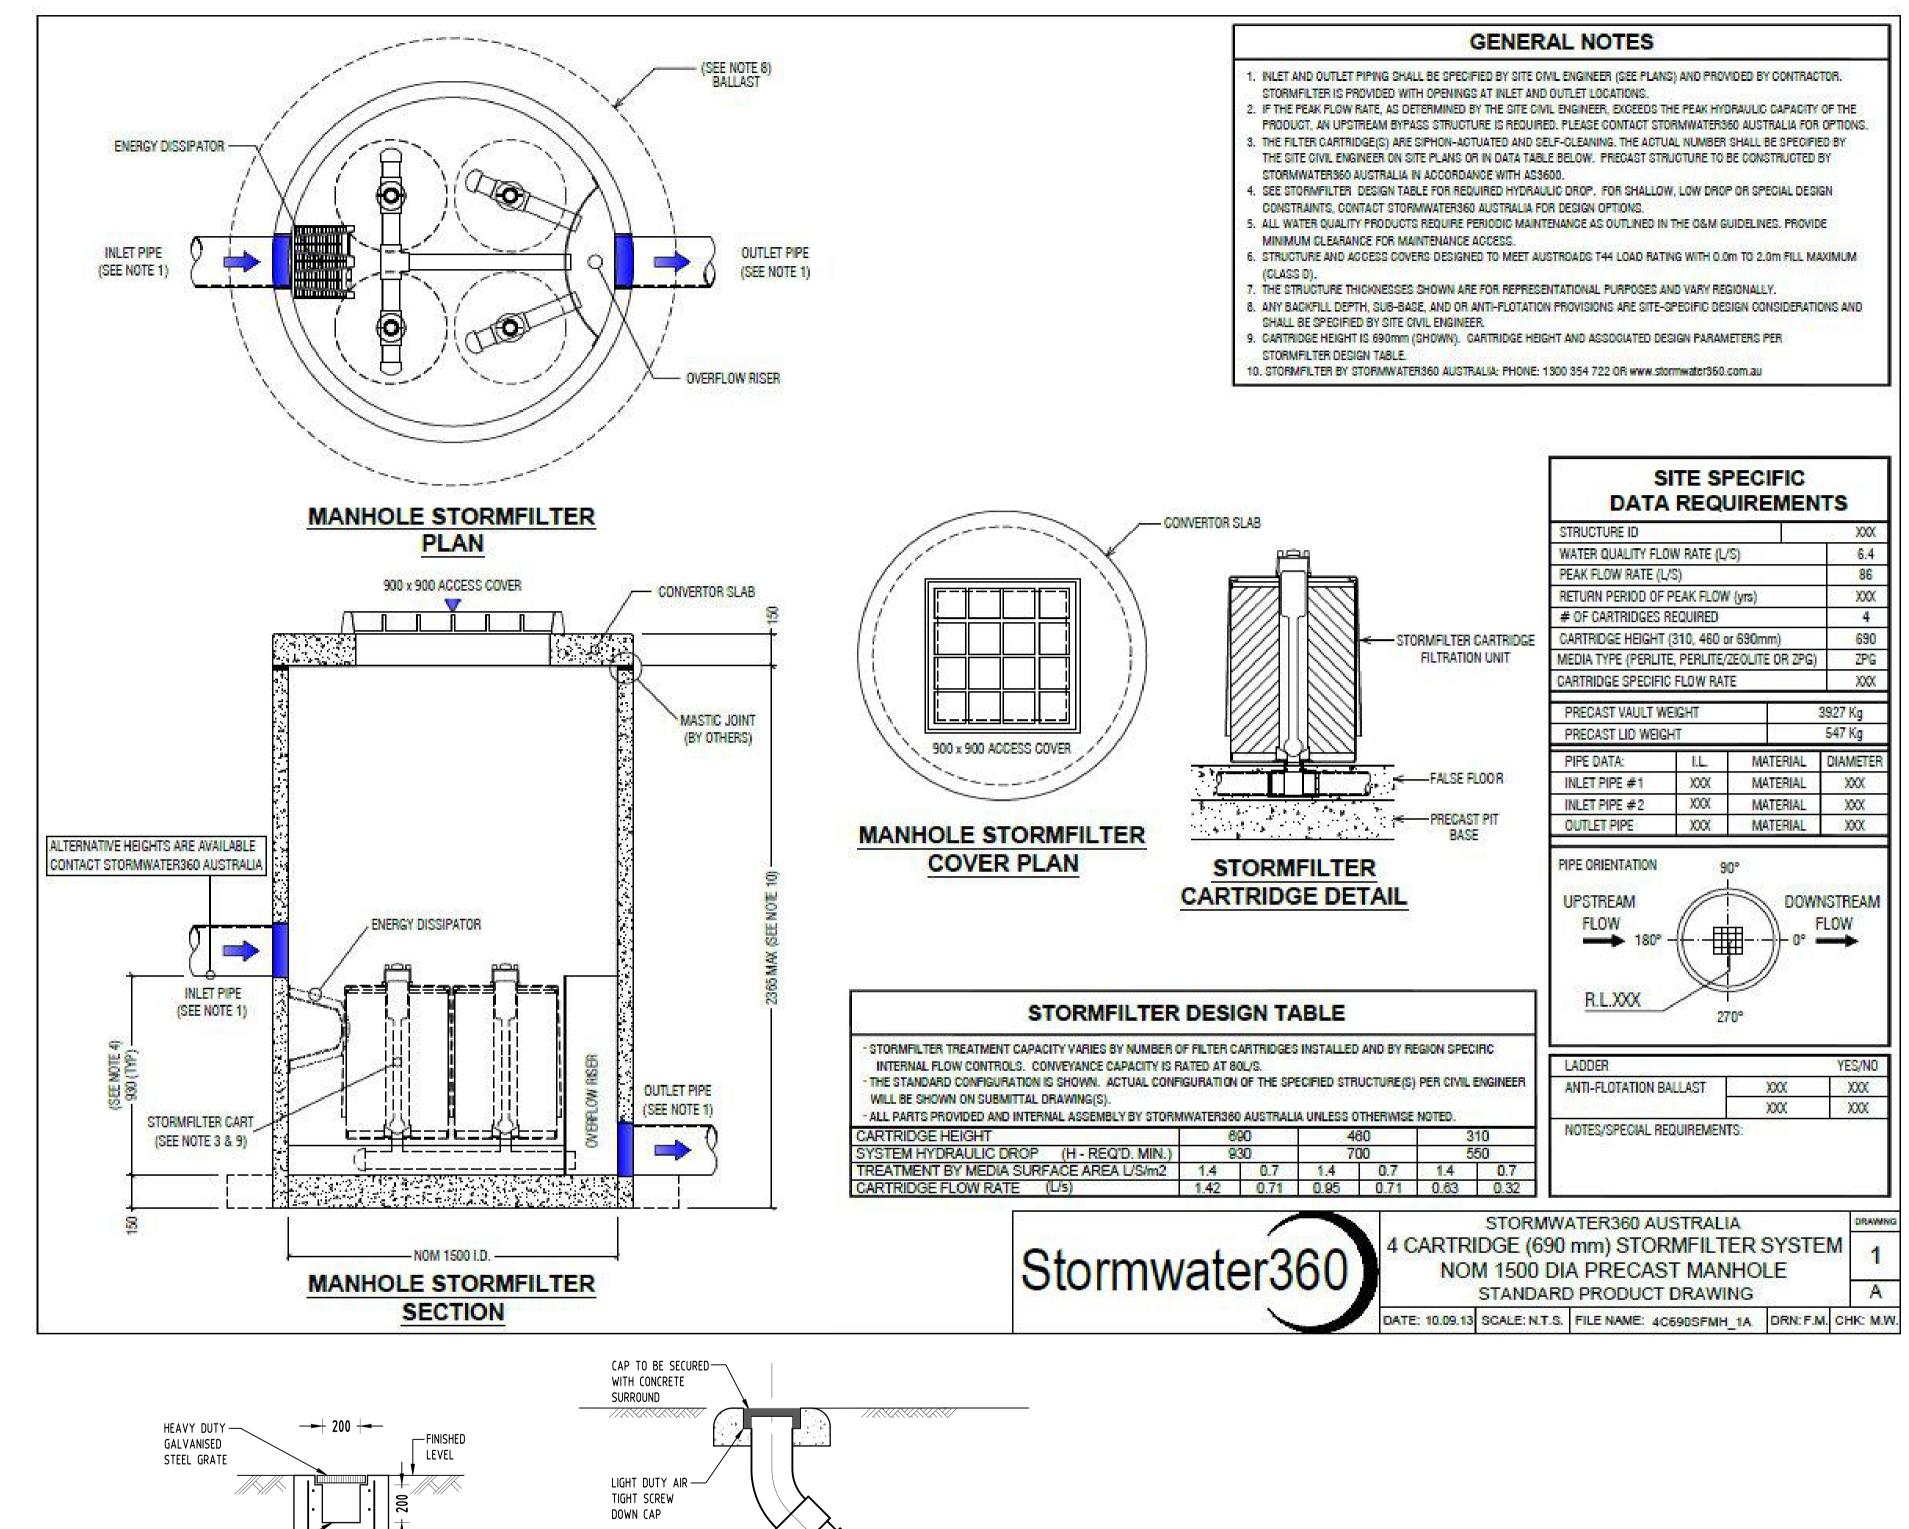



SITE AREA = 4106m²

TP: 65%

TN: 45%

ON-SITE DETENTION (OSD) IS NOT REQUIRED AS ADVISED BY COUNCIL'S STORMWATER ENGINEER.

WSUD IS REQUIRED FOR THE PROPOSED DEVELOPMENT. TARGETS: TSS: 85%

THE SITE IS SUBJECTED TO 1% ANNUAL EXCEEDANCE PROBABILITY FLOOD DUE TO MINOR OVERLAND FLOW WHICH ENTERS FROM MINTO ROAD. FLOOR LEVELS HAVE

BEEN RAISED UP AS PER COUNCIL'S FLOOD ADVICE SERVICES SHOWN ON PLAN ARE INDICATIVE, EXACT DEPTH AND LOCATION TO BE CONFIRMED ONSITE. CONTRACTOR TO CARRY OUT DIAL BEFORE -900x900 HEAVY DUTY REFER PLAN FOR DETAIL -YOU DIG APPLICATION AND ENGAGE A REGISTERED GALVANISED STEEL GRATE SURVEYOR TO PEG OUT ALL EXISTING SERVICES

LEGEND:

STORMWATER LINE

———— AUTHORITY COMMS LINE

RAINWATER OUTLET

PLANTER DRAINS

DOWNPIPE

— SSD — SUBSOIL DRAINAGE LINE

PRIOR TO ANY WORK COMMENCING ONSITE.

BENCHING

AS SHOWN

ON PLAN

SECTION

PLAN WITHOUT GRATE

OUTLET PIPE

LINE OF

150mm PVC

OUTLET PIPE

WALL BELOW

LINE OF REBATE OVER FOR FRAME

HEAVY DUTY GALV STEEL-

GRATE AND FRAME

SL82 FABRIC—


REINFORCEMENT


STEEL

150mm PV

150mm PVC


OUTLET PIPE

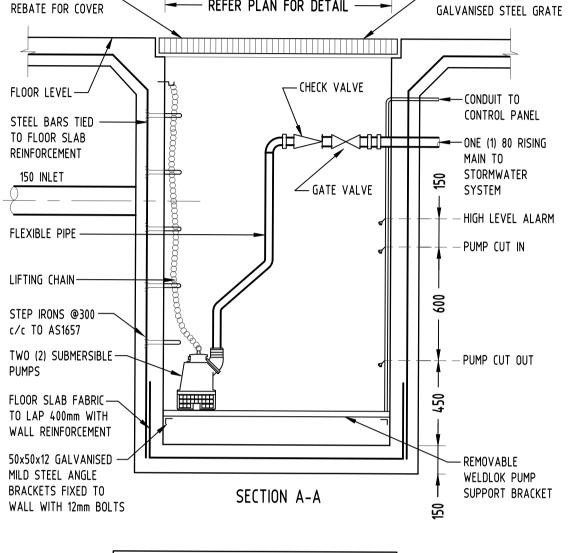


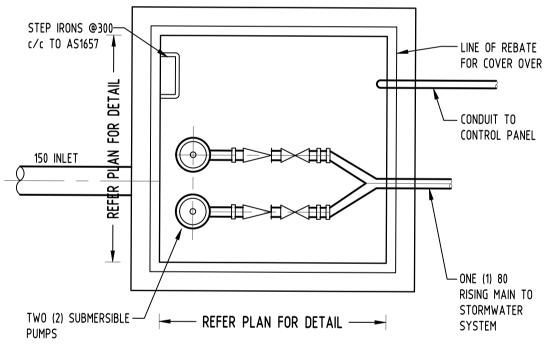




PLAN VIEW (WITHOUT COVER)

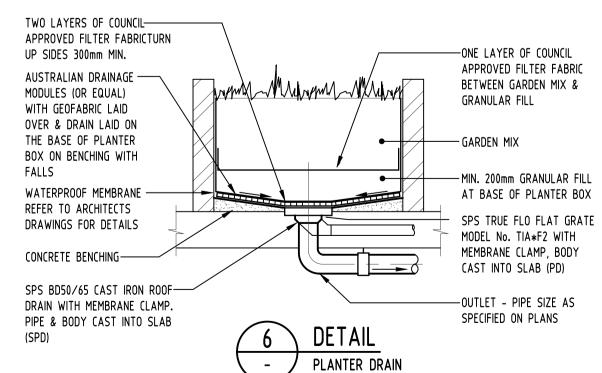

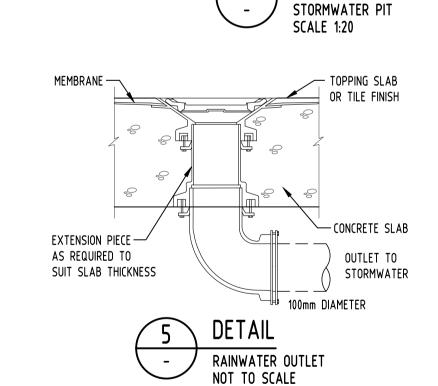

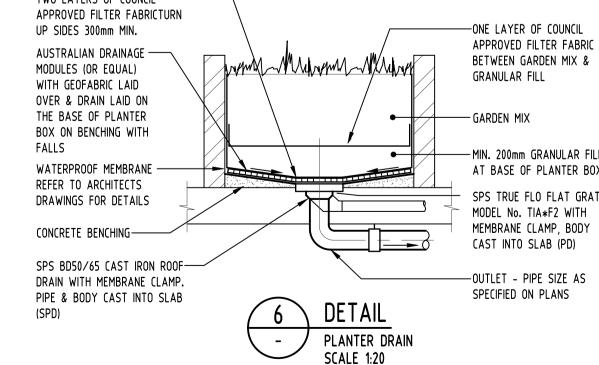

ŧΙ									
						Referenc	e Coordination Drawing		
2	D	AMENDED AS PER COUNCIL'S COMMENTS	JD	27.07.2020	2	Discipline	Drawing Title and Number	Date	F
<u> </u>	C	AMENDED AS PER COUNCIL'S COMMENTS	JD	09.07.2020	2	ARCH			$^{+}$
1	В	AMENDED AS PER COUNCIL'S COMMENTS	FZ	15.10.19	2	ARCH			+
3	A	FOR APPROVAL	FZ	26.03.19	2	STRUCT	+	-	+
2	P3	PRELIMINARY	FZ	22.03.19	1				+
<u> </u>	P2	PRELIMINARY	FZ	21.03.19	1	MECH			+
1	P1	PRELIMINARY	FZ	20.03.19	1	ELEC			╀
5						HYD			
<u> </u>	Issue	Last revision title	by	Date	Status	FIRE			
i [Issuer internal sequence and revision his	story	7		LANDS			T
		•					- i		_

3-construction certificate

6-other

2-development application


5-construction

GRATED TRENCH DRAIN

NOT TO SCALE

MINIMUM 1% GRADE-

BASE FALL TO OUTLET

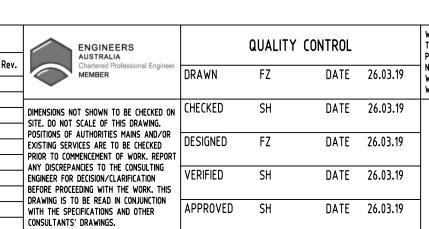

CLEANING EYE


SCALE 1:10

uPVC PIPE DRAINAGE -

LINE AT MIN 1.0%

GRADE

FLOW

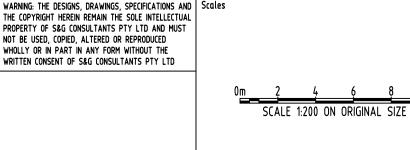

CLIENT AIMAN YOUSIF **AUSTRALIAN** CONSTRUCTION EXPERTS PTY LTD. ARCHITECT URBAN LINK PTYLID LEVEL 10, 11-15 DEANE ST, **BURWOOD NSW 2134** P.0.BOX 2223, BURWOOD NORTH NSW 2134 p 02-9745 2014 f 02-9745 0984

info@urbanlink.com.au



Suite 5.03, Level 5, 156 PACIFIC HIGHWAY ST. LEONARDS, NSW 2065 T: +61 2 8883 4239 Web: www.sgce.com.au

A.B.N. 21 118 222 530

PROJECT PROPOSED RESIDENTIAL DEVELOPMENT Email: office@sgce.com.au 12-16 FRANCIS STREET,

Datum


A.H.D.

5 OF 7

Scale (at original size)

AS SHOWN

FOR APPROVAL NOT TO BE USED FOR CONSTRUCTION PURPOSES STORMWATER CONCEPT DESIGN DETAILS SHEET

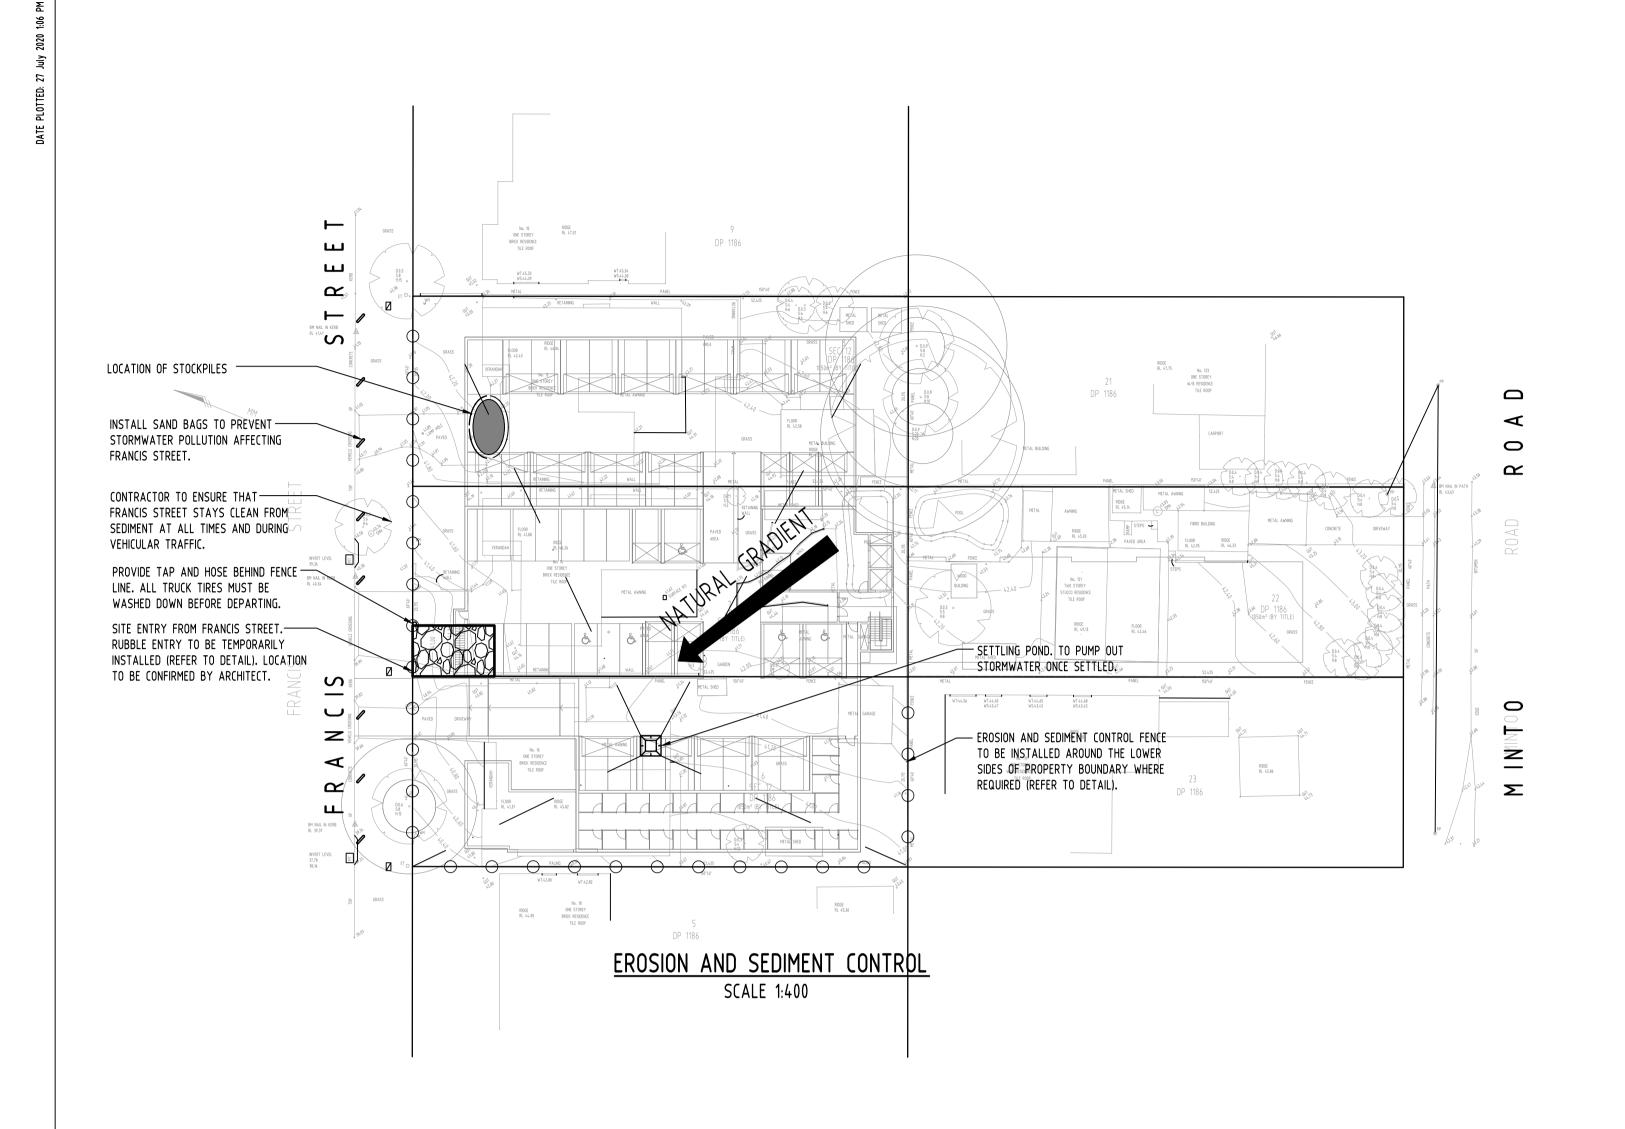

EROSION & SEDIMENTATION CONTROL NOTES

- 1. CONTRACTOR SHALL PROVIDE SEDIMENT FENCING MATERIAL DURING CONSTRUCTION TO THE LOW SIDE OF THE WORKS. TIE SEDIMENT FENCING MATERIAL TO CYCLONE WIRE SECURITY FENCE. SEDIMENT CONTROL FABRIC SHALL BE AN APPROVED MATERIAL (EG. HUMES PROPEX SILT STOP) STANDING 300mm ABOVE GROUND & EXTENDING 150mm BELOW GROUND.
- 2. EXISTING DRAINS LOCATED WITHIN THE SITE SHALL ALSO BE ISOLATED BY SEDIMENT FENCING MATERIAL.
- 3. NO PARKING OR STOCKPILING OF MATERIALS IS PERMITTED ON THE LOWER SIDE OF THE SEDIMENT FENCE.
- 4. GRASS VERGES SHALL BE MAINTAINED AS MUCH AS PRACTICAL TO PROVIDE A BUFFER ZONE TO THE CONSTRUCTION SITE.

TIMBER SPACER TO SUIT -


5. CONSTRUCTION ENTRY/EXIT SHALL BE VIA THE LOCATION NOTED ON THE DRAWING. CONTRACTOR SHALL ENSURE ALL DROPPABLE SOIL & SEDIMENT IS REMOVED PRIOR TO CONSTRUCTION TRAFFIC EXITING SITE. CONTRACTOR SHALL ENSURE ALL CONSTRUCTION TRAFFIC ENTERING & LEAVING THE SITE DO SO IN A FORWARD DIRECTION.

GENERAL NOTES


- 1. THIS PLAN IS A CONCEPT PLAN ONLY FOR STORMWATER DISPOSAL & EROSION CONTROL. IT IS NOT SUITABLE FOR CONSTRUCTION. THIS PLAN SHOULD BE ADAPTED BY THE BUILDER DURING DEMOLITION, EXCAVATION & CONSTRUCTION PHASES TO ENSURE ADEQUATE PERFORMANCE.
- 2. ALL DRAINAGE LAYOUT & DETAILS ARE DIAGRAMMATIC & INDICATIVE ONLY. ACTUAL LOCATION, SIZES, LEVELS & GRADES MAY ALTER WHEN DETAIL DESIGN WORKS ARE DOCUMENTED.

CLAY SOILS

- A SYSTEM SHALL BE INSTALLED TO EITHER:
- 1. TRANSPORT STORMWATER RUNOFF WITH SUSPENDED SOLIDS FROM SITE VIA PUMP TRUCKS.
- 2. TREAT THE STORMWATER RUNOFF WITH SUSPENDED SOLIDS SO THE DISCHARGE WATER QUALITY TO COUNCIL STORMWATER DRAINAGE SYSTEM HAS A MAXIMUM CONCENTRATION OF SUSPENDED SOLIDS THAT DOES NOT EXCEED 50 MILLIGRAMS PER LITRE IN ACCORDANCE WITH THE PROTECTION OF THE ENVIRONMENT OPERATION ACT (POEO 1997) AND SHALL BE APPROVED BY LOCAL COUNCIL

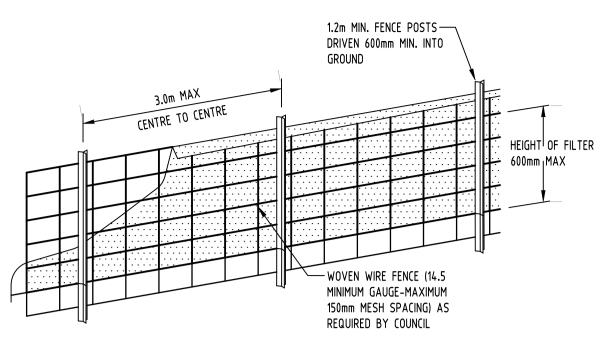

DIAGRAMMATIC VIEW

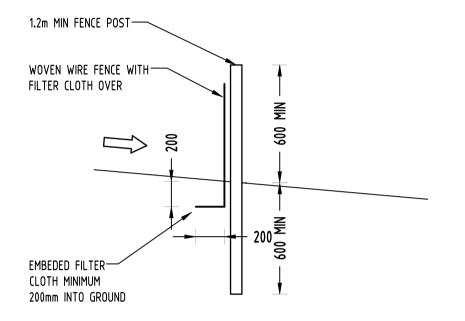


TYPICAL SECTION

SEDIMENT FENCE

NOT TO SCALE

GEOTEXTILE INLET FILTER

GEOTEXTILE INLET FILTER IS PLACED IN EVERY PIT WITHIN THE SITE TO ENSURE THE RUNOFF WATER DURING CONSTUCTION NOT ENTER THE PITS.

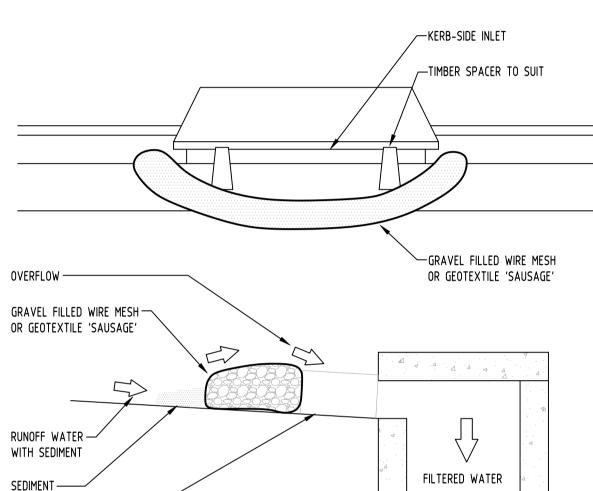

CONSTRUCTION NOTES:

FABRICATE A SLEEVE MADE FROM GEOTEXTILE OR WIRE MESH LONGER THAT THE LENGTH OF THE INLET PIT

FILL THE SLEEVE WITH 25mm TO 50mm GRAVEL

FORM AN ELLIPTICAL CROSS-SECTION OF THE KERB INLET LEAVING A 100mm GAP AT THE TOP TO ACT AS AN EMERGENCY SPILLWAY


MAINTAIN THE OPENING WITH SPACER BLOCKS


FORM A SEAL WITH THE KERBING AND PREVENT SEDIMENT BYPASSING THE FILTER

FIT TO ALL KERB INLETS AT SAG POINTS

GRAVEL INLET FILTER (SAUSAGE)

NOT TO SCALE

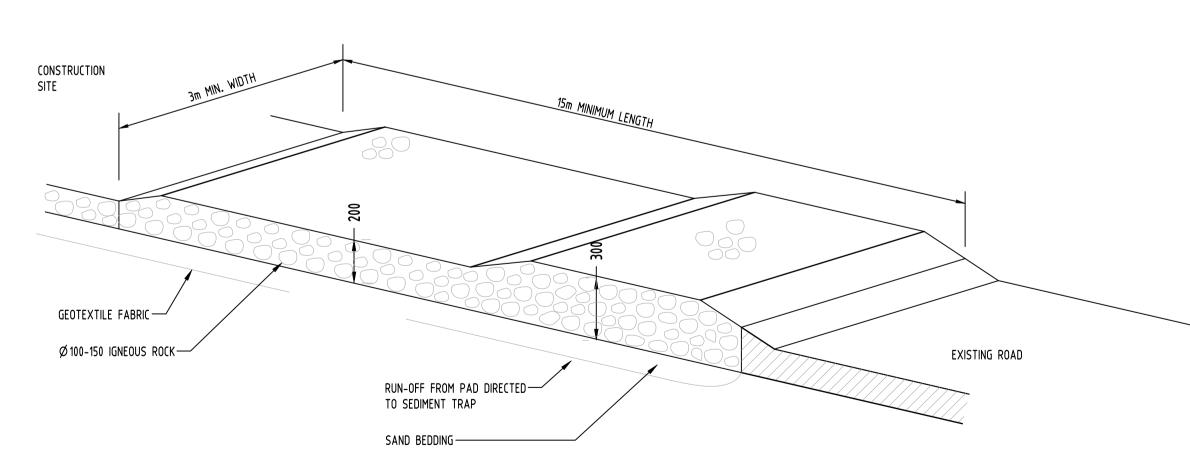

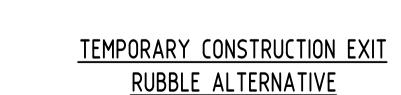

NOT TO SCALE

					Reference	Coordination Drawing		ENGINEERS	QUALITY CONTROL					
D	AMENDED AS PER COUNCIL'S COMMENTS	JD	27.07.2020	2	Discipline	Drawing Title and Number	Date	Rev.		AUSTRALIA Chartered Professional Engineer	221111			
C	AMENDED AS PER COUNCIL'S COMMENTS	JD	09.07.2020	2	ARCH					MEMBER	DRAWN	FZ	DATE	26.03.19
В	AMENDED AS PER COUNCIL'S COMMENTS	FZ	15.10.19	2	ARCH									
Α	FOR APPROVAL	FZ	26.03.19	2	STRUCT) Dimensions N	OT SHOWN TO BE CHECKED ON	CHECKED	SH	DATE	26.03.19
Р3	PRELIMINARY	FZ	22.03.19	1	MECH				SITE. DO NOT	SCALE OF THIS DRAWING.				
P2	PRELIMINARY	FZ	21.03.19	1						AUTHORITIES MAINS AND/OR VICES ARE TO BE CHECKED	DESIGNED	FZ	DATE	26.03.19
P1	PRELIMINARY	FZ	20.03.19	1	ELEC HYD				PRIOR TO COM	IMENCEMENT OF WORK. REPORT		· -	3,,,,2	23.334.7
_					⊣ HYIJ		I							

LEGEND

Issuer internal sequence and revision history

6-other

2-development application

5-construction

SEDIMENT FENCE

SANDBAGS

STABILISED SITE ACCESS

ANY DISCREPANCIES TO THE CONSULTING ENGINEER FOR DECISION/CLARIFICATION BEFORE PROCEEDING WITH THE WORK. THIS DRAWING IS TO BE READ IN CONJUNCTION

WARNING: THE DESIGNS, DRAWINGS, SPECIFICATIONS AND THE COPYRIGHT HEREIN REMAIN THE SOLE INTELLECTUAL PROPERTY OF S&G CONSULTANTS PTY LTD AND MUST NOT BE USED, COPIED, ALTERED OR REPRODUCED WHOLLY OR IN PART IN ANY FORM WITHOUT THE WRITTEN CONSENT OF S&G CONSULTANTS PTY LTD

-DROP INLET

WITH GRATE

FILTER FABRIC

BURIED 0.2m

SCALE 1:400 ON ORIGINAL SIZE

SILT FENCE-

RUN-OFF WATER

WITH SEDIMENT

GEOTEXTILE INLET FILTER

NOT TO SCALE

AIMAN YOUSIF **AUSTRALIAN** CONSTRUCTION

FILTERED WATER

URBAN LINK PTYLID LEVEL 10, 11-15 DEANE ST, BURWOOD NSW 2134

Suite 5.03, Level 5, 156 PACIFIC HIGHWAY ST. LEONARDS, NSW 2065 T: +61 2 8883 4239 Web: www.sgce.com.au

PROJECT PROPOSED RESIDENTIAL DEVELOPMENT

FOR APPROVAL NOT TO BE USED FOR CONSTRUCTION PURPOSES **EROSION AND SEDIMENT CONTROL**

PLAN AND DETAILS

P.0.BOX 2223, BURWOOD NORTH Email: office@sgce.com.au 12-16 FRANCIS STREET, NSW 2134 p 02-9745 2014 f 02-9745 0984 EXPERTS PTY LTD. by Date Status FIRE info@urbanlink.com.au Scale (at original size) Engineering Value 3-construction certificate APPROVED SH WITH THE SPECIFICATIONS AND OTHER A.H.D. 6 OF 7 AS SHOWN A.B.N. 21 118 222 530 CONSULTANTS' DRAWINGS.

